
WALNUT CREEK SEWER REPAIR


CITY OF CRETE NEBRASKA 243 EAST 13TH STREET **CRETE**, **NE** 68333

JEO Project No.: 241729.00

LOCATION MAP

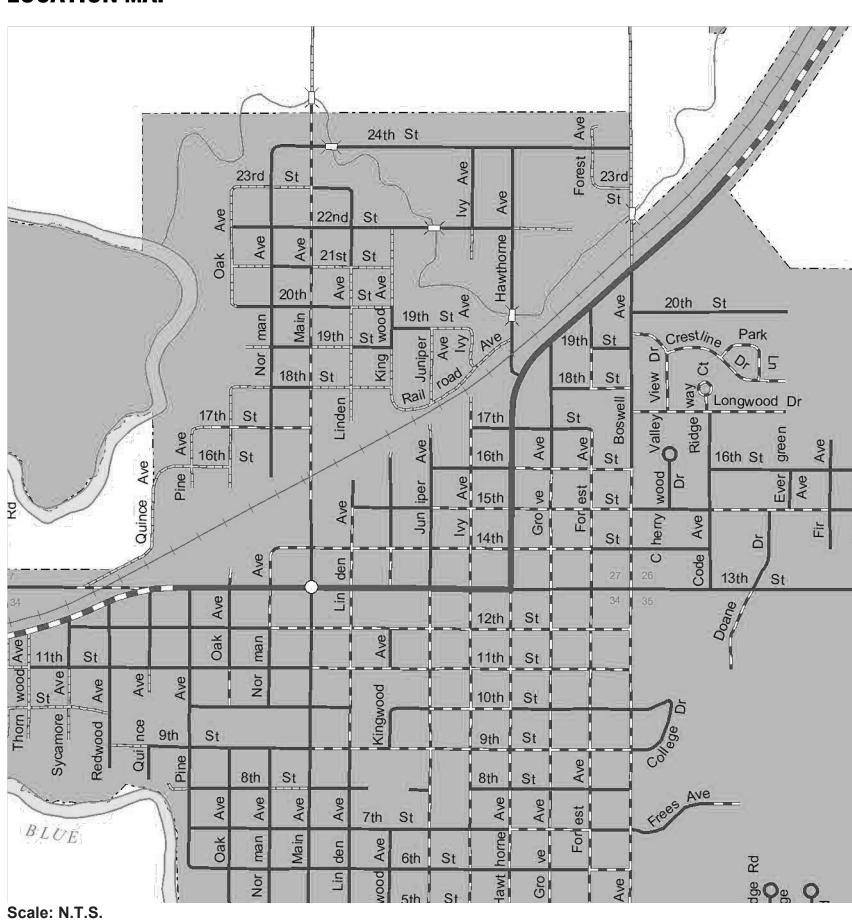

SHEET IDENTIFICATION

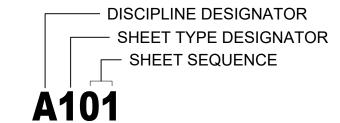

DISCIPLINE DESIGNATOR		
G	GENERAL	
С	CIVIL	
А	ARCHITECTURAL	
S	STRUCTURAL	
М	MECHANICAL	
Р	PLUMBING	
Е	ELECTRICAL	

	SHEET TYPE DESIGNATOR
0	GENERAL
1	PLANS AND COMBINATION PLAN & PROFILE
2	ELEVATIONS AND PROFILES
3	SECTIONS
4	LARGE SCALE VIEWS
5	DETAILS
6	SCHEDULES AND DIAGRAMS
7	NOT USED
8	NOT USED
9	3D REPRESENTATIONS

OWNER:

Address: CITY OF CRETE NEBRASKA 243 EAST 13TH STREET CRETE, NE 68333

Contact Info: TOM OURADA TOM.OURADA@CRETE.NE.GOV P: 402.826.4312 | F: 402.826.4334

COORDINATING PROFESSIONAL:



JEO CONSULTING GROUP

Address: AARON D. BEAUCLAIR 2000 Q ST. #500 LINCOLN, NE 68503

Contact Info: AARON D. BEAUCLAIR, P.E. ABEAUCLAIR@JEO.COM P: 402.474.8744

I, AARON D. BEAUCLAIR, am the coordinating professional on the Walnut Creek Sewer Repair project.

CIVIL ENGINEER:



Address: AARON D. BEAUCLAIR 2000 Q ST. #500 LINCOLN, NE 68503

Contact Info: AARON D. BEAUCLAIR, P.E. ABEAUCLAIR@JEO.COM P: 402.474.8744

STRUCTURAL ENGINEER:



Know what's **below**.

All site plan information is based upon **US SURVEY FEET (sFT)**

Call before you dig.

JEO CONSULTING GROUP

Address: CODY LUREEN 2000 Q ST. #500 LINCOLN, NE 68503 **Contact Info:** CODY LUREEN, P.E. CLUREEN@JEO.COM P: 402.435.3080

UTILITIES

WATER:

Contact Info: CITY OF CRETE

TOM.OURADA@CRETE.NE.GOV P: 402.826.4312 | F: 402.826.4334

SEWER:

Contact Info: CITY OF CRETE TOM.OURADA@CRETE.NE.GOV P: 402.826.4312 | F: 402.826.4334

ELECTRIC:

Contact Info: CITY OF CRETE TOM.OURADA@CRETE.NE.GOV P: 402.826.4312 | F: 402.826.4334

TELEPHONE:

Contact Info: WINDSTREAM COMMUNICATIONS P: 1.866.445.8084

FIBER OPTIC:

Contact Info: ALLO COMMUNICATIONS LLC P: 515.635.4610

INDEX OF SHEETS

SHEET NO. **SHEET NAME** G001 COVER SYMBOLS G002 V101 HORIZONTAL AND VERTICAL CONTROL C101 SITE PLAN BYPASS PUMPING PLAN C102 C201 PLAN AND PROFILE **DETAILS** C501 STRUCTURAL DETAIL

WALNUT CREEK SEWER REPAIR

10/28/2024

JEO CONSULTING GROUP

THIS DOCUMENT WAS

ORIGINALLY SIGNED

ON 10/29/2024 BY

AARON D. BEAUCLAIR,

A LICENSED

PROFESSIONAL

ENGINEER IN THE

STATE OF NEBRASKA

E-16150

DESCRIPTION

1937 N CHESTNUT ST WAHOO, NE 68066

800.723.8567 | jeo.com

Organization Certificate of

Authorization Number: CA-0069

JEO CONSULTING GROUP

1937 N CHESTNUT ST WAHOO, NE 68066

800.723.8567

ISSUE

CRETE, NEBRASKA LAT: 40°38'03.62" N LONG: 96°57'32.63" W

241729.00 **JEO Project No.:** 22" x 34" **Sheet Size:** Drawn by: ADP QAQC: EEJ - 10/17/2024



COVER

NOTE: NEITHER THE OWNER (CLIENT) NOR JEO CONSULTING GROUP, INC. ASSUMES ANY RESPONSIBILITY FOR UTILITY LOCATIONS BEING ACCURATELY SHOWN OR NOT SHOWN ON THE PLANS. A REQUEST FOR UTILITY LOCATES WAS MADE FOR THIS LOCATION AS PER THE ONE-CALL NOTIFICATION SYSTEM ACT.

(DATE: 9/10/2024 TICKET NO.: 242540093). (DATE: 9/10/2024 TICKET NO.: 242540094).

UTILITIES SHOWN ARE FROM FIELD MARKINGS PROVIDED IN THE FIELD BY THE UTILITY PROVIDERS.

THE EXACT LOCATION AND/OR SIZE OF UNDERGROUND FEATURES MAY NOT BE ACCURATELY, COMPLETELY AND RELIABLY DEPICTED. FIELD VERIFICATION OF UTILITIES MAY BE REQUIRED. CONTRACTOR(S) SHALL NOTIFY THE RESPECTIVE UTILITY COMPANIES BEFORE COMMENCING ANY WORK.

RECORD DRAWINGS

THESE RECORD DRAWINGS REPRESENT A COMPILATION OF INFORMATION AND FIELD MEASUREMENTS PROVIDED BY OTHERS. ALL DIMENSIONS AND DTAILS HAVE NOT BEEN VERIFIED BY JEO CONSULTING GROUP, INC.

CONSTRUCTION COMPLETED <u>04/2025</u>

LINESTYLES

ITEM	SYMBOL	
BREAK LINE		_
CABLE TELEVISION	— UTV —— UTV —— —	_
CABLE TV (NS)	— <utv> — — - <utv> — — -</utv></utv>	_
CENTERLINE OF ROAD		_
CONTOUR MINOR (EX)	— — — 1202 — — —	
CONTOUR MAJOR (EX)	1200	
CONTOUR MINOR (EX,SCREENED)	— — 1202 — — —	
CONTOUR MAJOR (EX,SCREENED)	1200	
CONTOUR MINOR (PR)	1202	
CONTOUR MAJOR (PR)	1200	
LIMITS OF CONSTRUCTION	—LOC —— LOC —— —	
CULVERT	STIS	
ELECTRIC (OVHD)	— OHE — — OHE — —	_
ELECTRIC (OVHD, NS)	— <0HE> — — <0HE> — —	_
ELECTRIC (UGND)	— UGE — UGE — —	_
ELECTRIC (UGND, NS)	— <uge> — — <uge> — —</uge></uge>	_
FENCE (WOODEN)		_
FENCE (WIRE OR UNKNOWN)	xxxx	_
FENCE (CHAINLINK)		_
FENCE (SECURITY) FIBER OPTIC LINE		_
FIBER OPTIC LINE (NS)	F0 F0 <f0> <f0></f0></f0>	
FLOWLINE (BREAKLINE)		
, ,		_
GAS LINE	G	_
GAS LINE (NS) GUARDRAIL		
PROPERTY BOUNDARY) o
PROPERTY LOT LINES (PR)		_
PROPERTY LINES (EX,NS)		_
RIGHT-OF-WAY LINE	ROW ROW	_
RAILROAD RIGHT-OF-WAY	RR ROW	_
RAILROAD TRACKS		_
RETAINING WALL		 =
SANITARY SEWER (EX)		_
SANITARY SEWER (NS)	— <san> — — - SAN> — —</san>	_
SANITARY SEWER (PR)		
SAN SEWER FORCE MAIN (EX)	— 8" FM —— 8" FM —— —	_
SAN SEWER FORCE MAIN (PR)		_
STORM SEWER (EX)	==== §7 ==== 12"ST ==== ===	_
	(OFFSET TO PIPE SIZE)	
STORM SEWER (NS)		_
STORM SEWER (PR)	12" ST	_
	(OFFSET TO PIPE SIZE)	
TELEPHONE LINE (UGND)	— UGT — UGT — —	<u> </u>
TELEPHONE LINE (UGND,NS)	— <ugt> — — <ugt> — —</ugt></ugt>	_
TELEPHONE LINE (OVHD)	— OHT — OHT — —	_
TELEPHONE LINE (OVHD,NS)	— OHT — OHT — —	_
TERRACE		_
CROPLINE		_
TRAVELED WAY	OHAM OHAM	_
WATER (EX)	— 6" W — 6" W —	_
WATER (NS)		_
WATER (PR) FIRE SERVICE	6" W 6" W	_
EXISTING	EX	_
EXISTING EXISTING, NOT-SURVEYED	NS	_
PROPOSED	PR	—
OVERHEAD	OVHD	_
	\ / \ / \ /	
UNDERGROUND	UGND	

RECORD DRAWINGS

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CONSTRUCTION COMPLETED 04/2025

COMMON HATCHING

ITEM	HATCH
ASPHALT PAVEMENT (EX.)	
CONCRETE PAVEMENT (EX.)	, A A A
GRAVEL (EX.)	
BRICK PAVEMENT (EX.)	
ASPHALT PAVEMENT (PR.)	
CONCRETE PAVEMENT (PR.)	, 4 , 4 , 4 , 4 , 4 , 4 , 4 , 4 , 4 , 4
CONCRETE SIDEWALK (PR)	
GRAVEL (PR.)	
BRICK PAVEMENT (PR.)	
RIP RAP	
SEEDING	\ \ \ \ \ \ \ \ \ \ \ \ \ \ \ \ \ \ \
MATTING	
UNDISTURBED EARTH	
EARTH	
GRANULAR FILL	
SAND MORTAR, PLASTER	
CONCRETE	
BRICK	
CONCRETE BLOCK	
METAL	
WOOD FRAMING	
WOOD FRAMING INTERRUPTED MEMBER	
BATT INSULATION	
RIGID INSUI ATION	

RIGID INSULATION

UTILITIES

STORM SEWER

ITEM

CURB INLET	
GRATE INLET	
CATCH BASIN	D
STORM SEWER MANHOLE	
SANITARY	
CLEANOUT	©
SEPTIC TANK	(S)
SANITARY MANHOLE	
	FIC
AIR CONDITIONING UNIT	A
ANTENNA	\triangle
ANCHOR POLE/POST	0
GUY POLE	-0
	,
GUY WIRE ANCHOR ELECTRICAL HIGHLINE TOWER (METAL	
OR CONCRETE)	
POWER POLE (EXISTING)	
POWER POLE (PROPOSED)	
POWER (ELEC) PEDESTAL	<u>т</u> Р
POWER (ELEC) PULL BOX OR	
MANHOLE	P
POWER (ELEC) METER	Þ
LIGHT POLE	*
TRAFFIC SIGNAL	8
TRAFFIC SIGNAL BOX	SB
TELEVISION PEDESTAL	TV
TELEVISION MANHOLE	
WATER	
WATER MANHOLE	
WATER WANTOLE WATER VALVE	₩ ⋈
WATER SHUT OFF OR	
CURB STOP	\otimes
WELL	\Leftrightarrow
WATER METER	W
WATER METER PIT	WP
YARD HYDRANT	X
WATER ELEVATION	
WATER TOWER	
FIRE HYDRANT (EXISTING)	~
FIRE HYDRANT (PROPOSED)	~
FIRE HYDRANT IN PROFILE	
WATER FITTINGS	
11- 1/4°	I
22- 1/2°	Į
45°	Ţ
90°	口
CROSS	<u>H</u>
PLUG]
REDUCER	
TEE	Щ
GAS	
GAS METER	G
GAS MANHOLE	G
GAS FILL PIPE	0
GAS PUMP	
GAS VALVE	Š
GAS VENT	\bigcirc
TELEPHONE	
FIBER OPTICS PULL BOX	FO
TELEPHONE POLE	Ø
TELEPHONE PULL BOX OR	(T)
MANHOLE	
TELEPHONE PEDESTAL	
MANHOLE (NON-SPECIFIC)	0
UNDERGRND STORAGE TANK	(UST)
VALVE (NON-SPECIFIC)	\bowtie
	·

SITE & SIGNAGE

SYMBOL

ITEM	SYMBOL
SIGN	_0_
BARRICADE	
ROAD SIGNS	
COUNTY ROAD	0
INTERSTATE HIGHWAY	0
STATE HIGHWAY	0
U.S. HIGHWAY	0
MILE MARKER POST	M
RIGHT OF WAY MARKER	R
RAILROAD CROSSING SIGNAL	®
RAILROAD SWITCH	*
FLAG POLE	0
MAILBOX	а
PROPANE TANK	
SATELLITE TV DISH	Q
WINDMILL	X

CONTROL & FLEVATION

CONTROL & ELEVATION		
ITEM	SYMBOL	
BENCHMARK	BW	
CONTROL POINT (NON-PROPERTY)	•	
MONUMENT FOUND (PROPERTY)	•	
MONUMENT SET	•	
TEMPORARY POINT	0	
TEST BORING		
POINT ELEVATION (EXISTING)	× 0.00	
POINT ELEVATION (PROPOSED)	+00000010	
TOP OF PAVEMENT	TP	
TOP OF CURB	TC	
GROUND	GR	
TOP OF WALL	TW	
BOTTOM OF WALL	BW	
FLOWLINE	FL	
GRID TICK	+	

MISC FEATURES

ITEM	SYMBOL
CENTER PIVOT	8
CEMETERY	
GRAVE	G
CHURCH	Ť
CAVE	(Ĉ)
CISTERN	G
LATRINE	\Diamond
OIL WELL	ð
GUARD POST	0

PAVING FEATURES

ITEM	SYMBOL
EXISTING PAVEMENT JOINT	
TRANSVERSE JOINT	
LONGITUDINAL JOINT	
EXPANSION/KEYED JOINT	
PAVEMENT MARKING	
PAVEMENT REBAR	
HANDICAP SYMBOL	Ġ

VEGETATION

ITEM	SYMBOL
BUSH	0
CONIFEROUS TREE	W. W.
DECIDUOUS TREE	
MARSH/WETLAND	<u> </u>
TREE MASS LINE	
TREE STUMP	200

SWPPP

ITEM	SYMBOL
SILT FENCE	—— SF ——— SF ——
INLET PROTECTION	
STRAW WATTLE CHECK	
STRAW BALE CHECK	
FLOW ARROW (PLAN)	→
AREA INLET FILTER PROTECTION	\otimes \boxtimes
	•

GENERAL

ITEM	SYMBOL
PLAN REVISION	1
NORTH ARROW	N
GRAPHIC SCALE PLAN	0 5 10
GRAPHIC SCALE PROFILE/ CROSS SECTION	HORIZ.= 0 0 00 00 00 VERT.= 0 0 00 00
KEYNOTE OR TABULAR NOTE	(101)
REFERENCED NOTE	4
ELEVATION	0000.00'
SECTION	1 1 101
ENLARGED DETAIL	D0.0

JEO CONSULTING GROUP

1937 N CHESTNUT ST WAHOO, NE 68066 800.723.8567 | jeo.com

Organization Certificate of Authorization Number: CA-0069

[Consultant Title and Discipline] Organization Certificate of Authorization Number: [XX-000] [Address Line 1] [City, State 000000] [000.000.0000]

THIS DOCUMENT WAS ORIGINALLY SIGNED ON 10/29/2024 BY AARON D. BEAUCLAIR, A LICENSED PROFESSIONAL **ENGINEER IN THE** STATE OF NEBRASKA E-16150

ISSUE

MARK	DATE	DESCRIPTIO
FD	10/28/2024	FINAL

WALNUT CREEK SEWER REPAIR

CRETE, NEBRASKA LAT: 40°38'03.62" N LONG: 96°57'32.63" W


JEO Project No.: Drawn by: QAQC:

22" x 34" ADP EEJ - 10/17/2024

241729.00



SYMBOLS

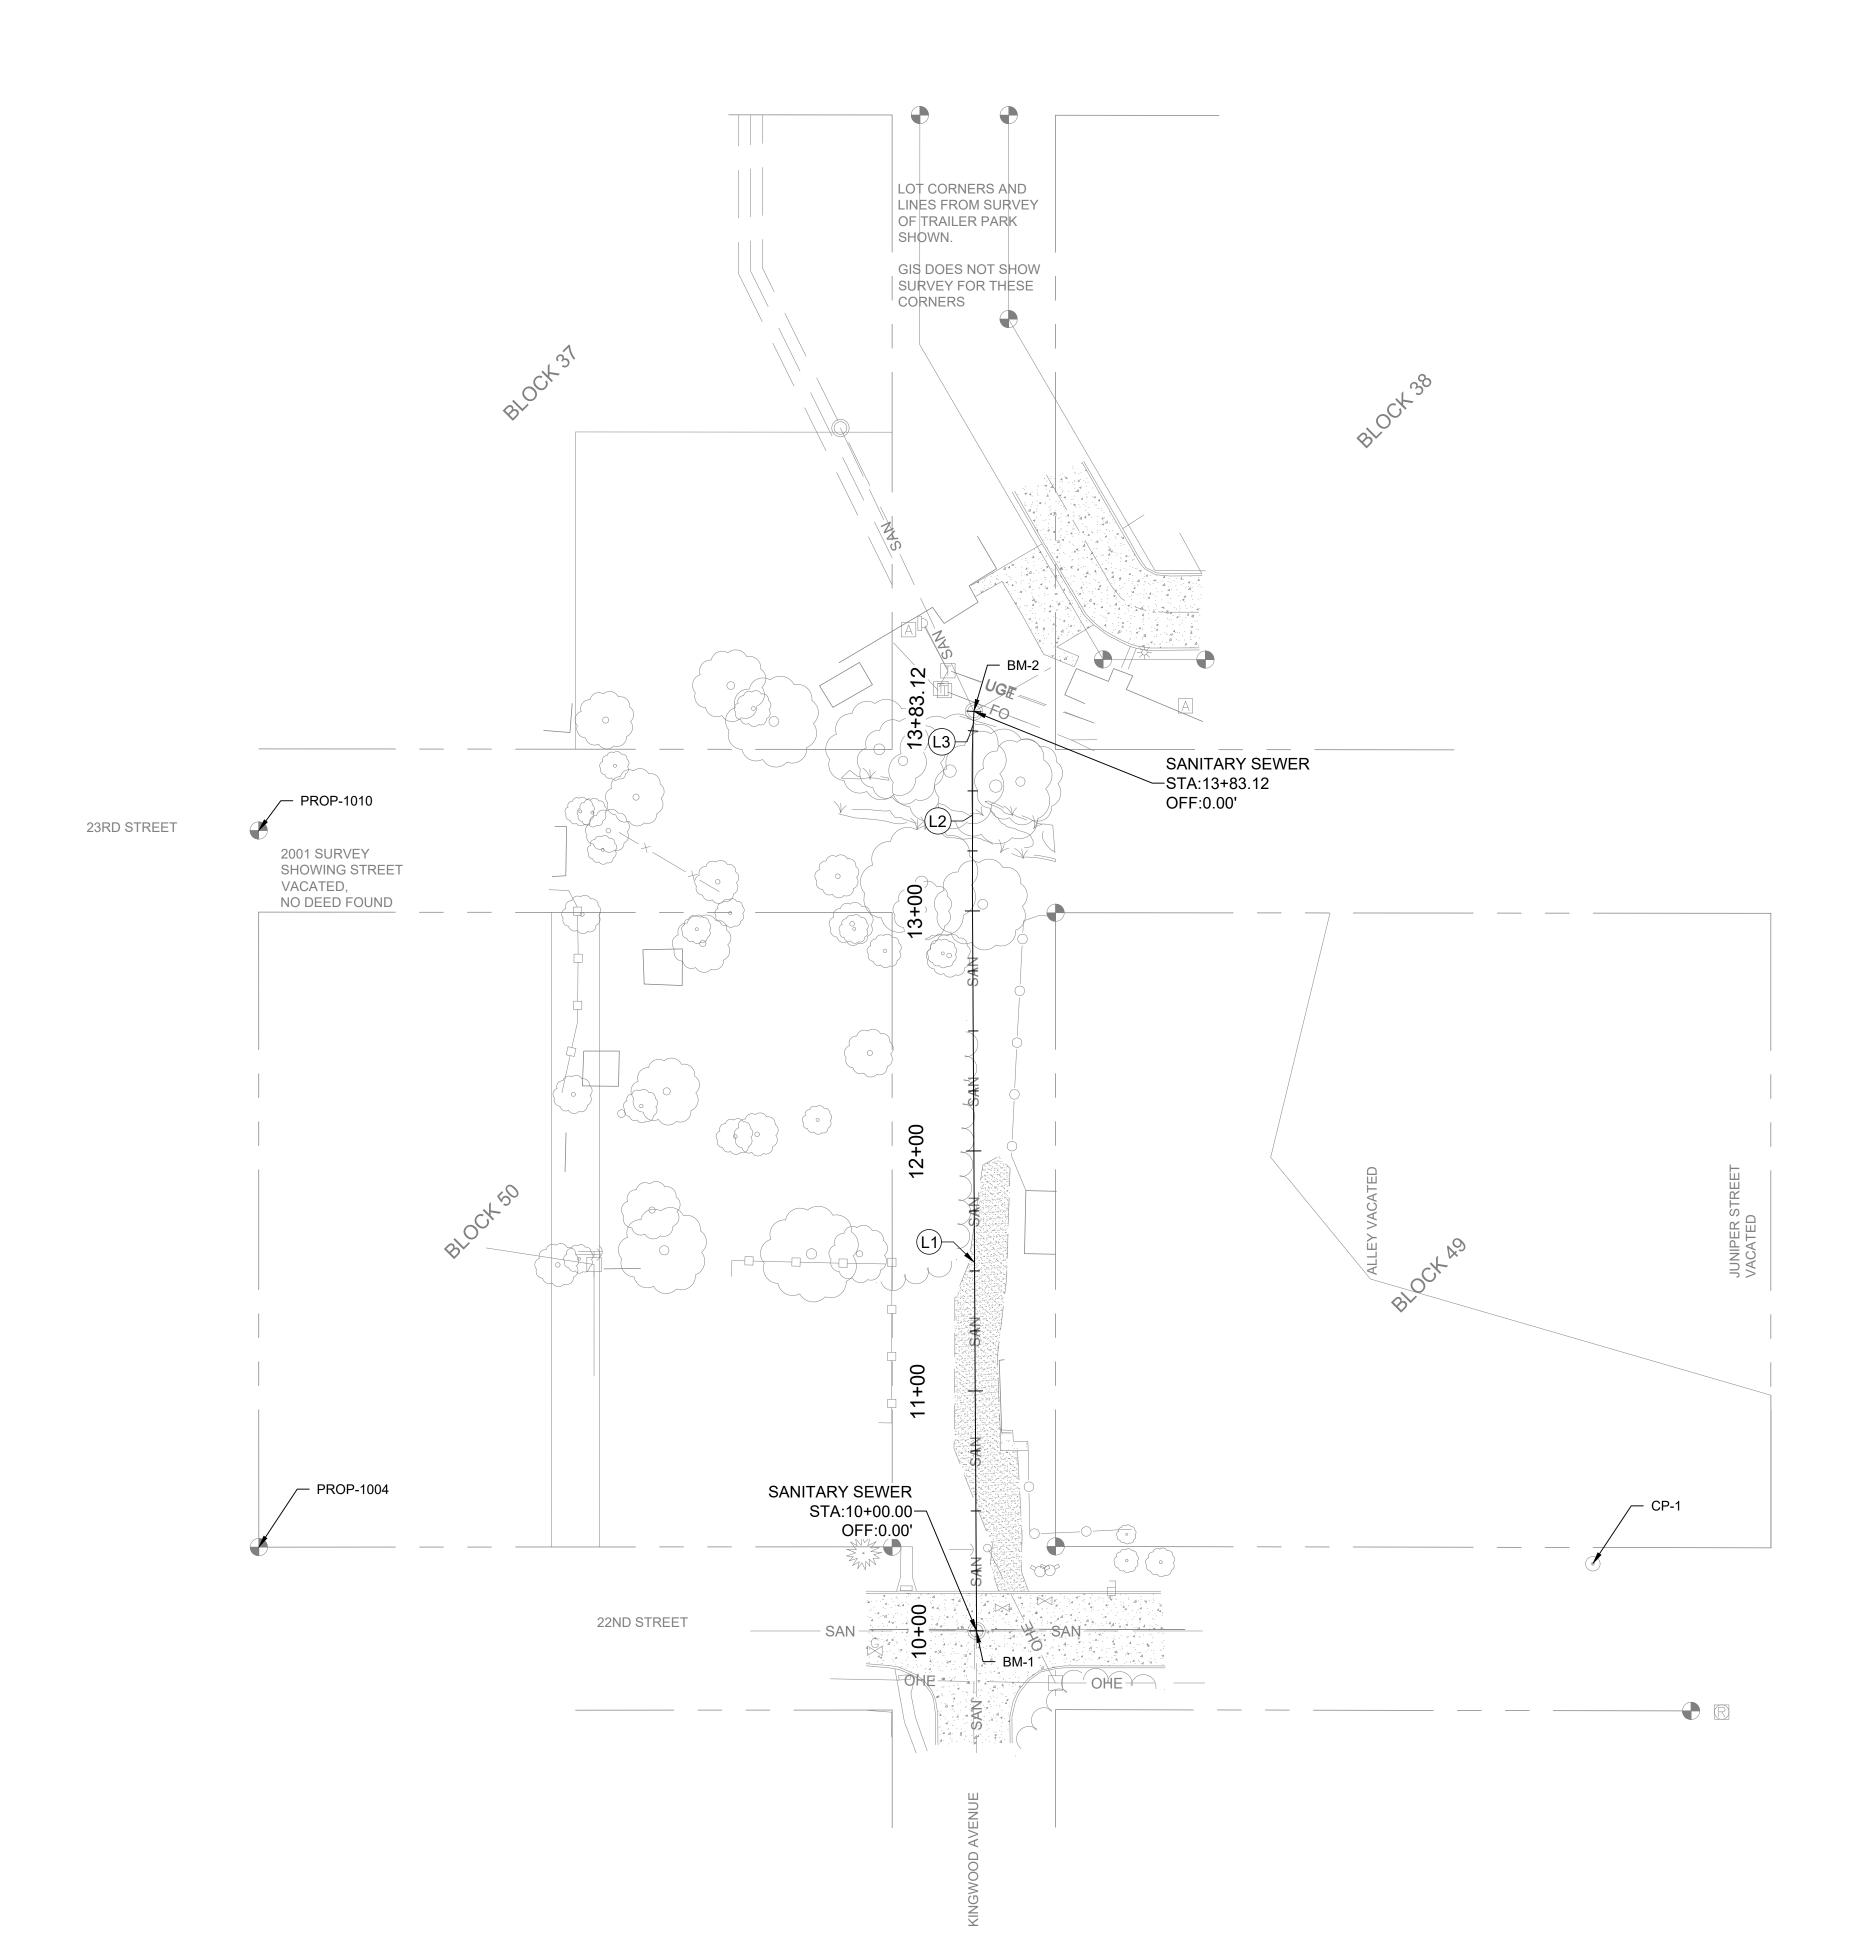

NOTE: CONSTRUCTION BENCHMARKS WILL BE ESTABLISHED BY JEO AT THE TIME OF CONSTRUCTION

HORIZONTAL SURVEY CONTROL - SALINE COUNTY LDP				
POINT	NORTHING	EASTING	LONG	
NAME	US SURVEY FEET	US SURVEY FEET	DESCRIPTION	
CP-1	108198.82	131070.90	MAG NAIL SET IN CONCRETE SIDE WALK	
PROP-1004	108205.76	130515.09	5/8" REBAR	
PROP-1010	108504.35	130515.03	5/8" REBAR	

B	BENCHMARKS - NAV88			
POINT NAME	NORTHING US SURVEY FEET	EASTING US SURVEY FEET	ELEVATION	LONG DESCRIPTION
BM-1	108171	130814	1353.33	SAMH RIM
BM-2	108554	130813	1352.83	SAMH RIM

SANITARY SEWER ALIGNMENT				
NUMBER	LENGTH	LINE/CHORD DIR	START STATION, N, E	END STATION N, E
L1	307.00	N00°19'13"W	10+00.00, 108170.84, 130814.14	13+07.00, 108477.84, 130812.43
L2	66.00	N00°06'29"E	13+07.00, 108477.84, 130812.43	13+73.00, 108543.84, 130812.55
L3	10.12	N02°51'57"E	13+73.00, 108543.84, 130812.55	13+83.12, 108553.95, 130813.06


JEO CONSULTING GROUP

1937 N CHESTNUT ST WAHOO, NE 68066 800.723.8567 | jeo.com

Organization Certificate of Authorization Number: CA-0069

LEGEND

SYMBO)L	DESCRIPTION
+00 	1+00	BASELINE ALIGNMENT (DESIGN)
<u>C1</u>		BASELINE ALIGNMENT CURVE TAG LABE
(L1)		BASELINE ALIGNMENT LINE TAG LABEL
		BASELINE ALIGNMENT PI POINT
\circ		POINT OF CURVATURE OR TANGENCY

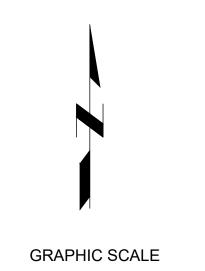

UNIT OF MEASURE IS FEET

RECORD DRAWINGS

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CONSTRUCTION COMPLETED ___04/2025

THIS DOCUMENT WAS ORIGINALLY SIGNED ON 10/29/2024 BY AARON D. BEAUCLAIR, A LICENSED PROFESSIONAL **ENGINEER IN THE** STATE OF NEBRASKA E-16150

ISSUE

MARK	DATE	DESCRIPTION
FD	10/28/2024	FINAL


WALNUT CREEK SEWER REPAIR

CRETE, NEBRASKA LAT: 40°38'03.62" N LONG: 96°57'32.63" W

241729.00 JEO Project No.: 22" x 34" Sheet Size: ADP Drawn by: QAQC: EEJ - 10/17/2024 Additional Project Info:



HORIZONTAL ALIGNMENT AND CONTROL

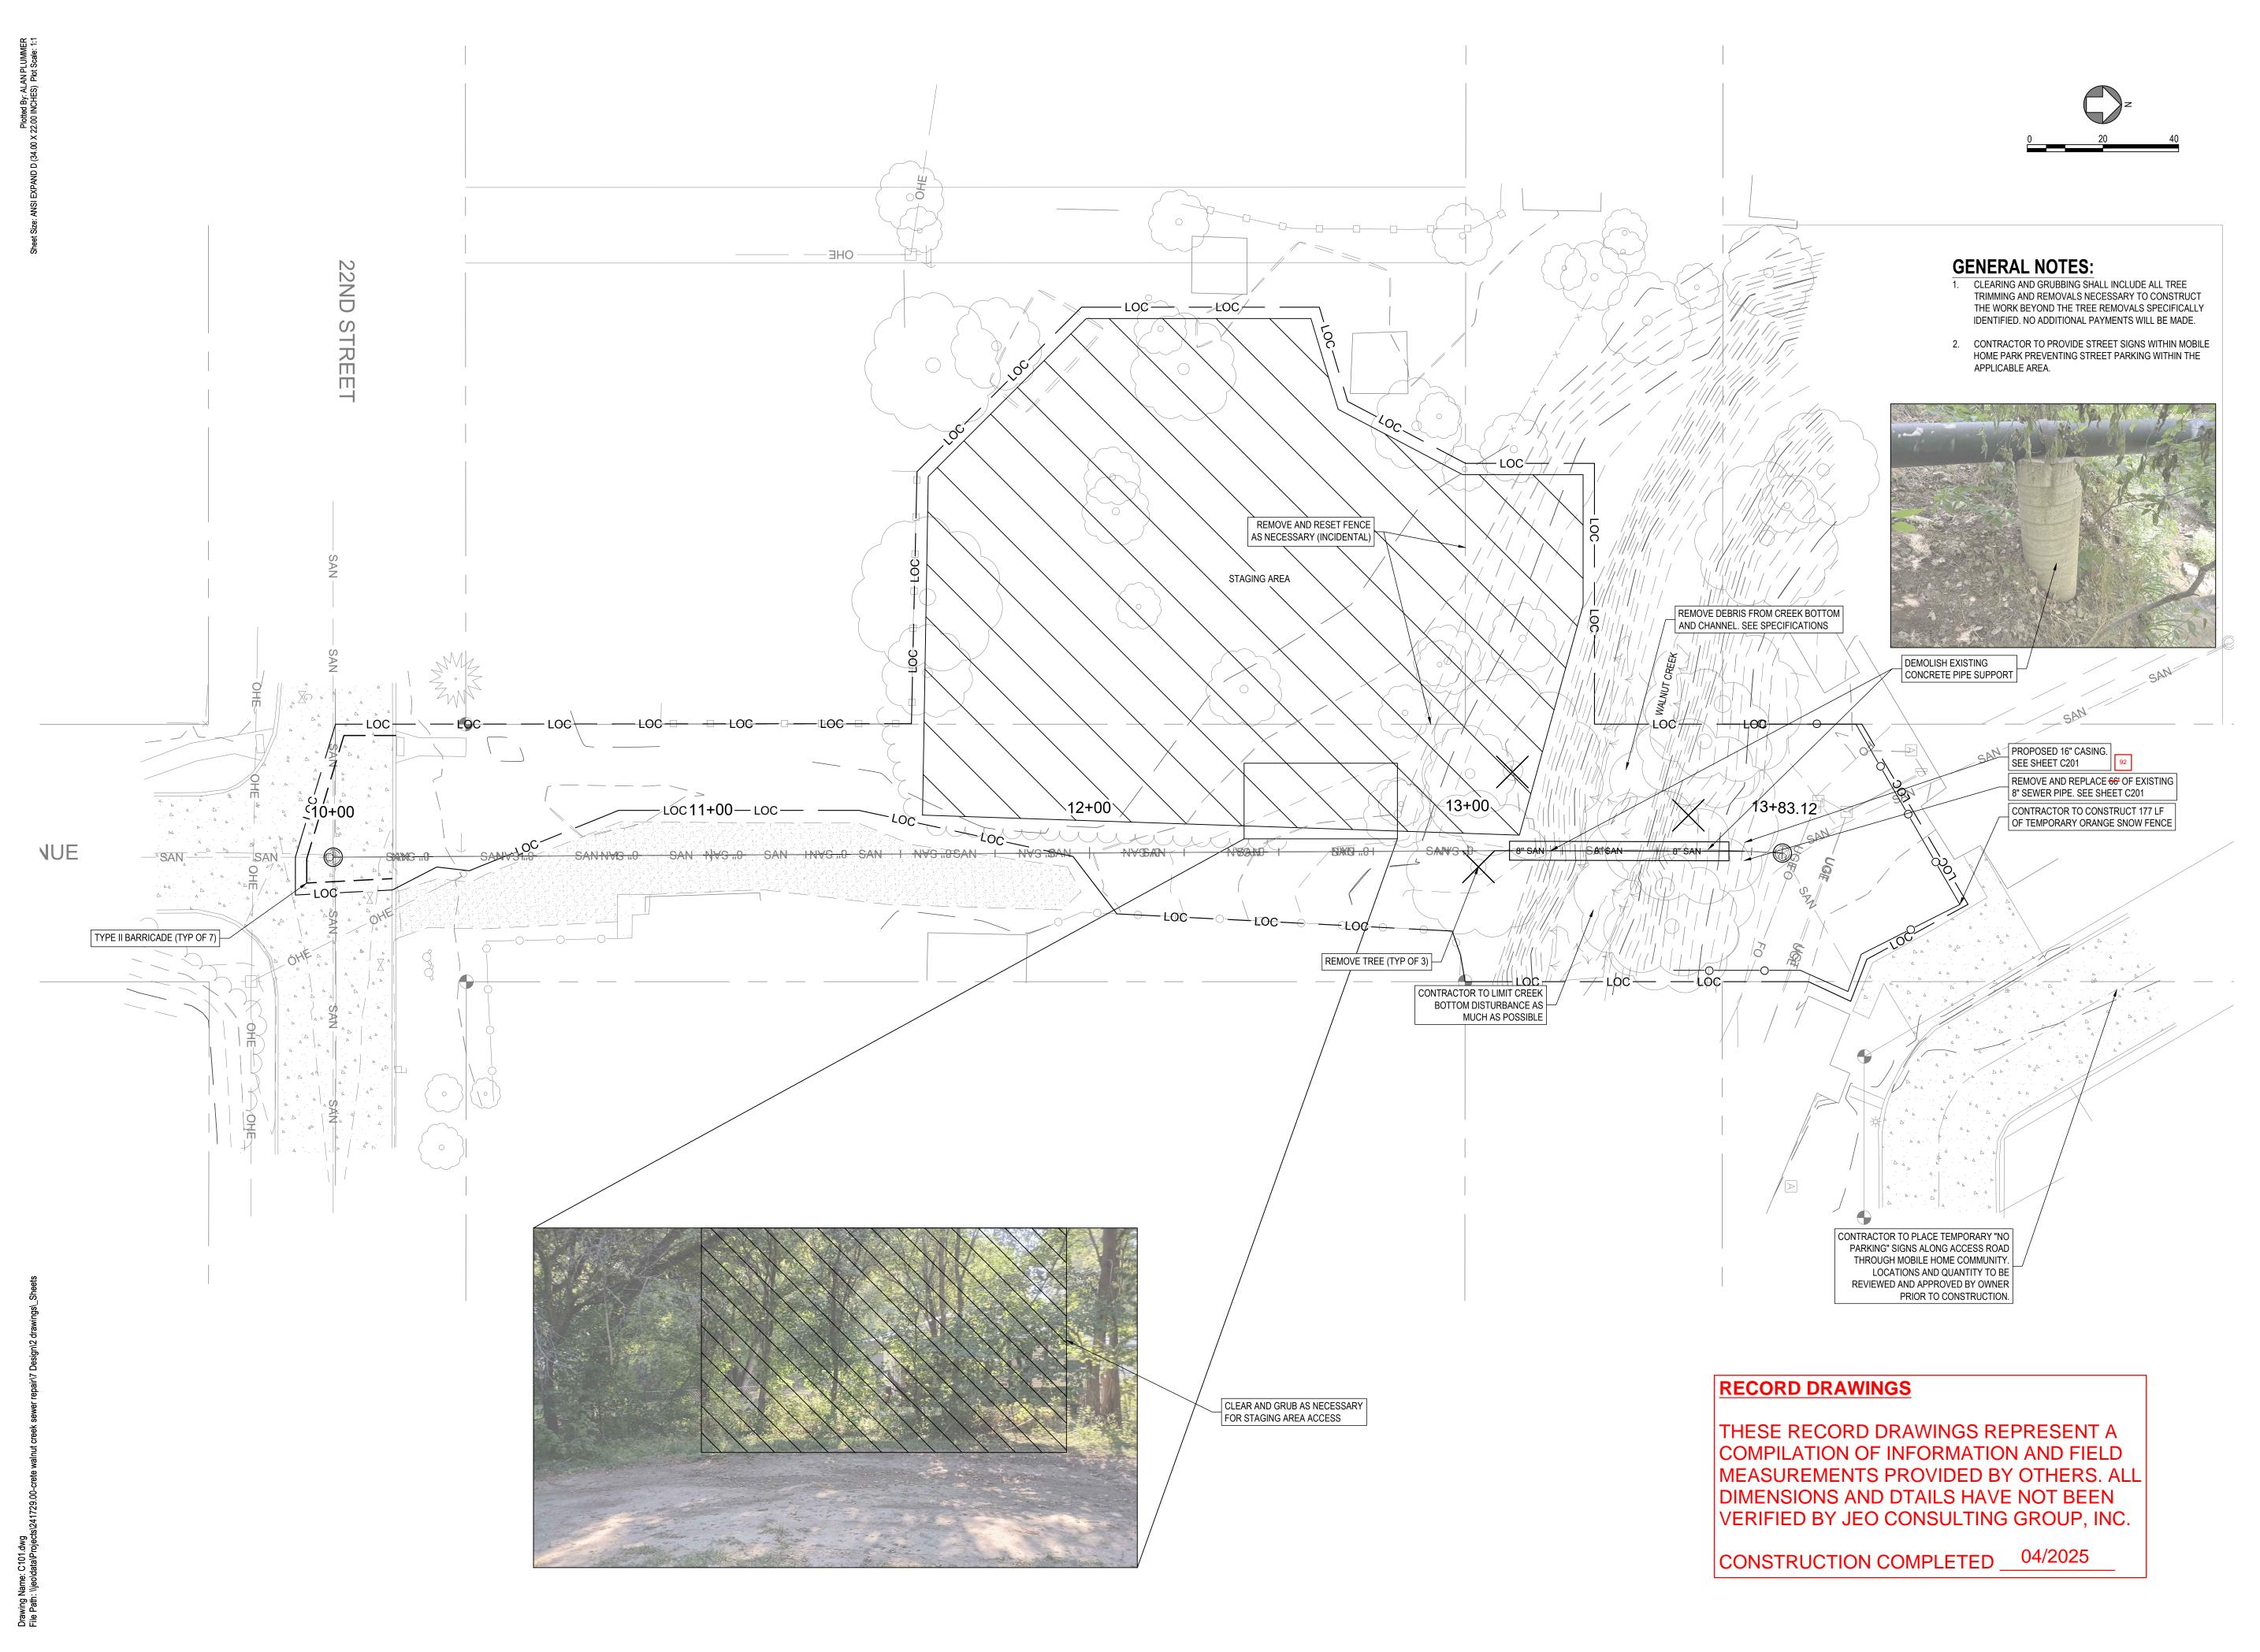



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Organization Certificate of Authorization Number: CA-0069

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AARON D. BEAUCLAIR,
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ENGINEER IN THE
STATE OF NEBRASKA
E-16150

ISSUE

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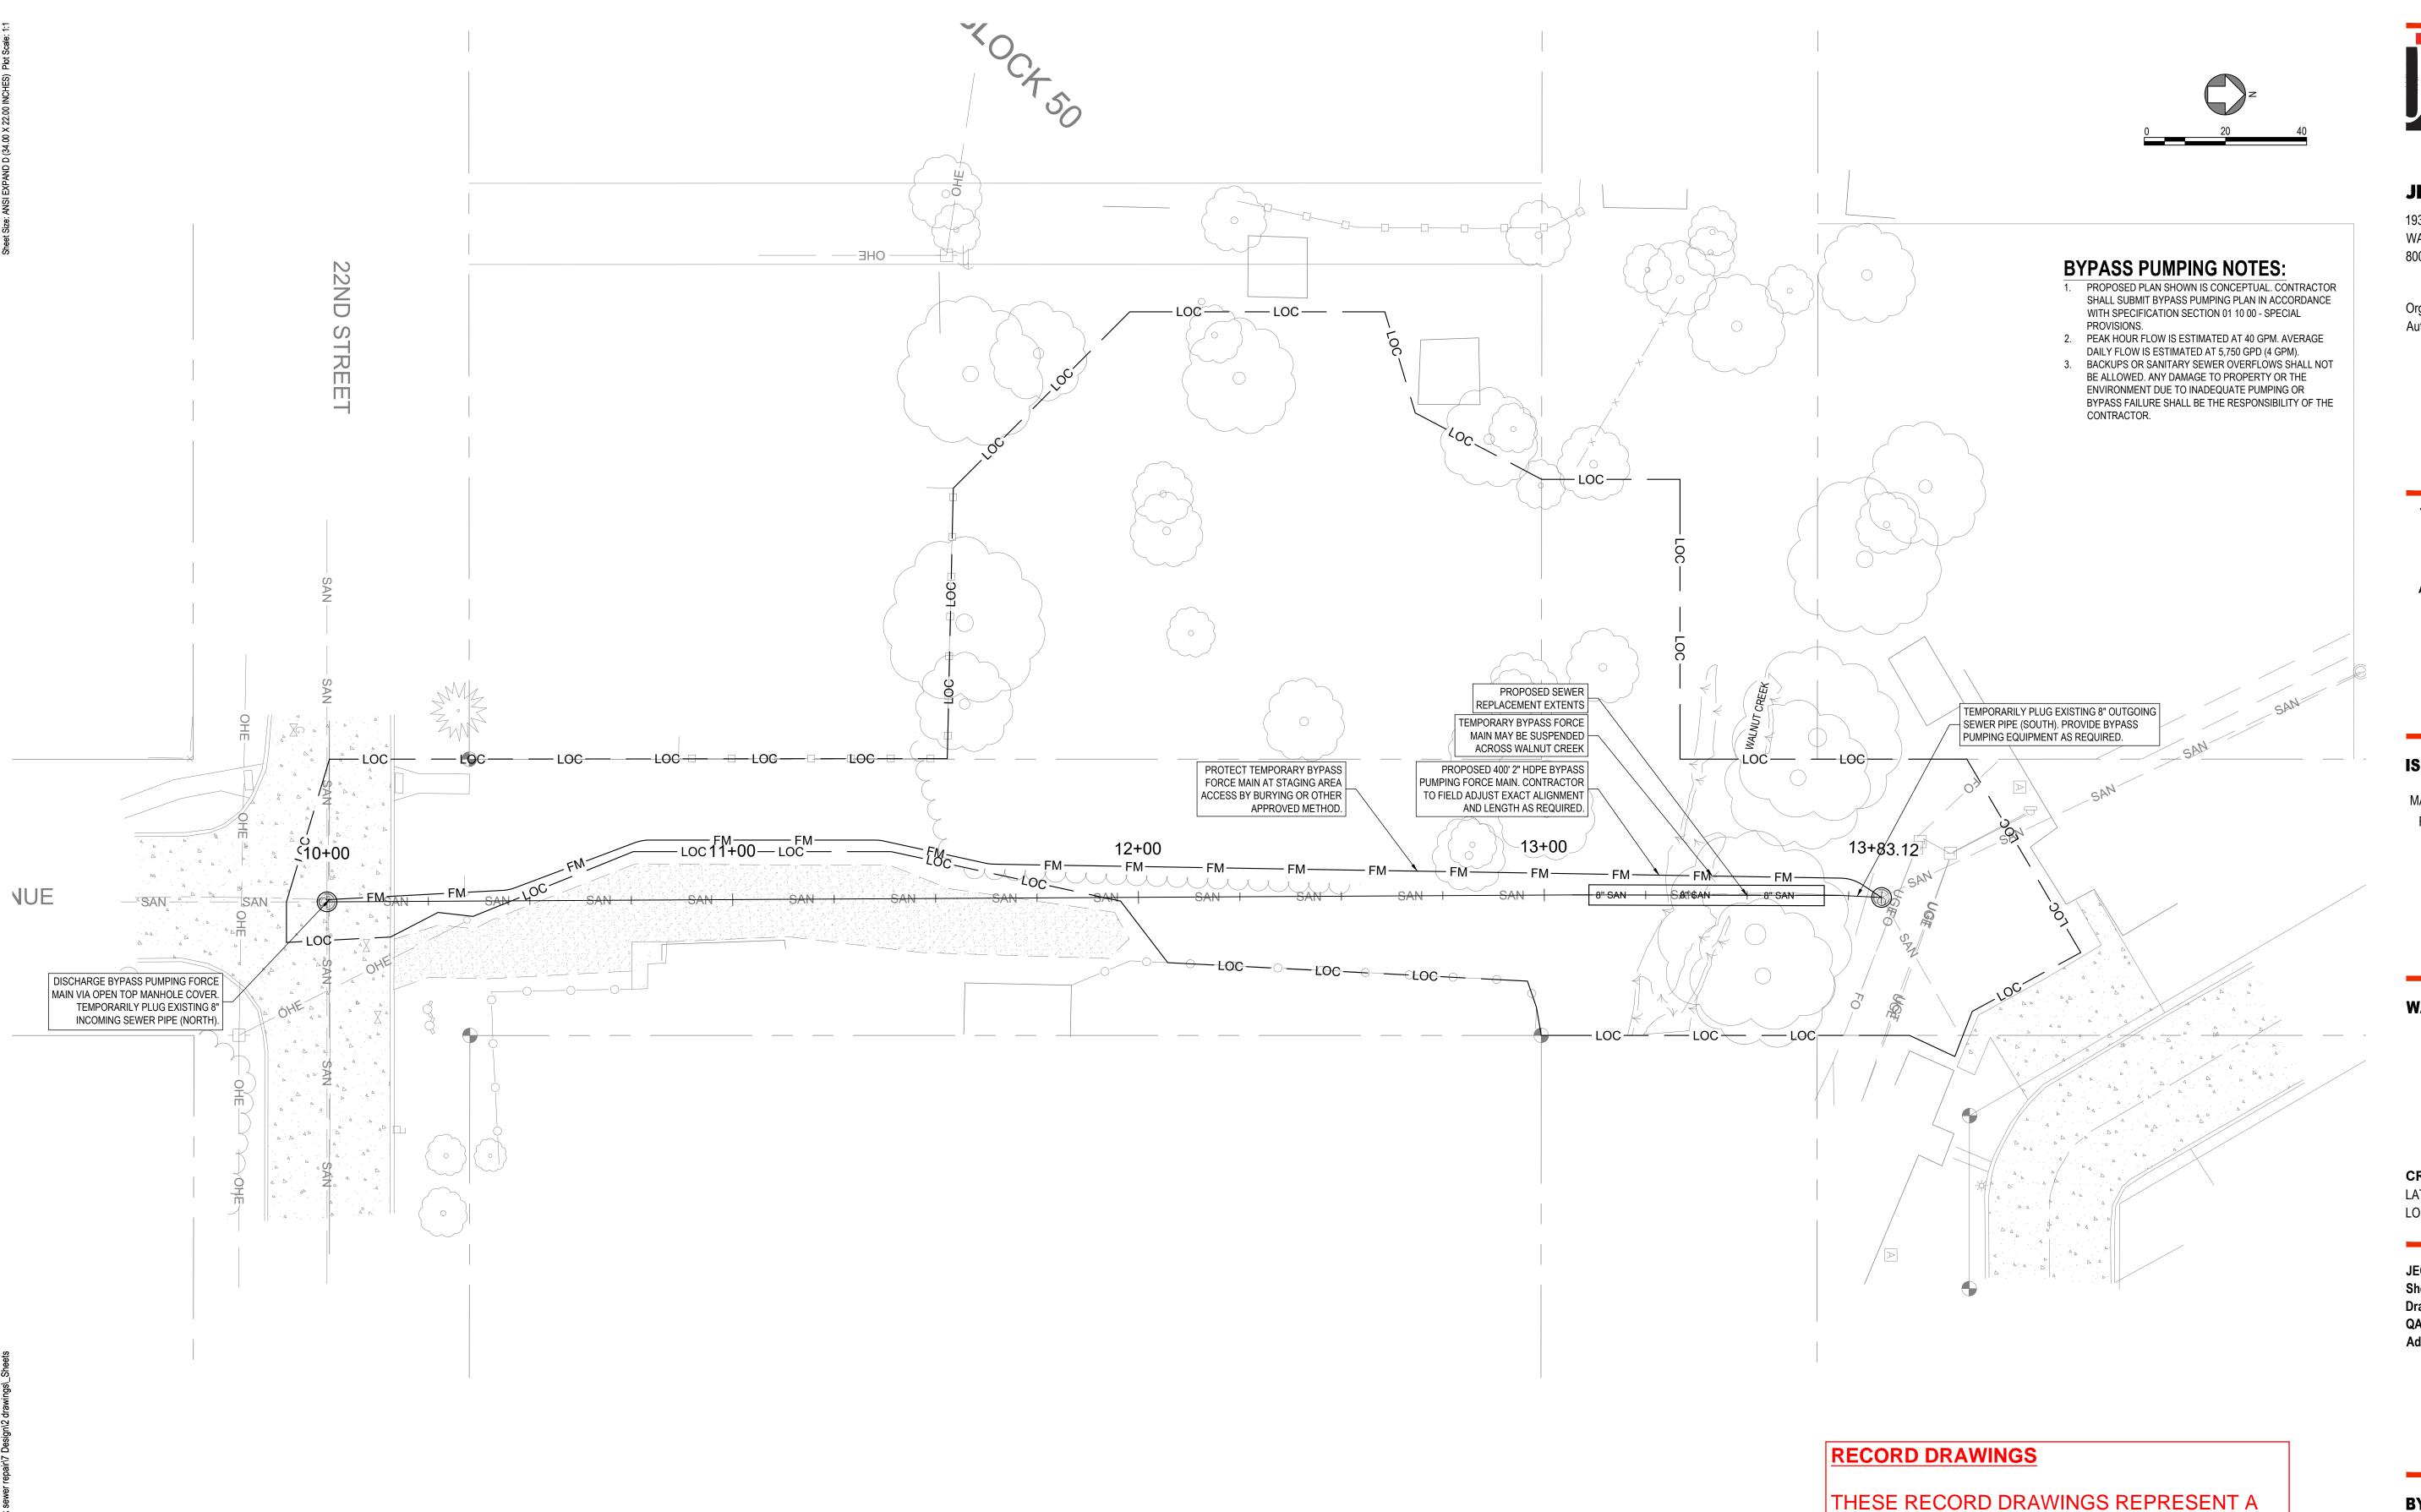
WALNUT CREEK SEWER REPAIR

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JEO Project No.: 241729.00
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QAQC: EEJ - 10/17/2024
Additional Project Info:



SITE PLAN





JEO CONSULTING GROUP

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Organization Certificate of Authorization Number: CA-0069

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Additional Project Info:



BYPASS PUMPING PLAN


COMPILATION OF INFORMATION AND FIELD

DIMENSIONS AND DTAILS HAVE NOT BEEN

CONSTRUCTION COMPLETED 04/2025

MEASUREMENTS PROVIDED BY OTHERS. ALL


VERIFIED BY JEO CONSULTING GROUP, INC.

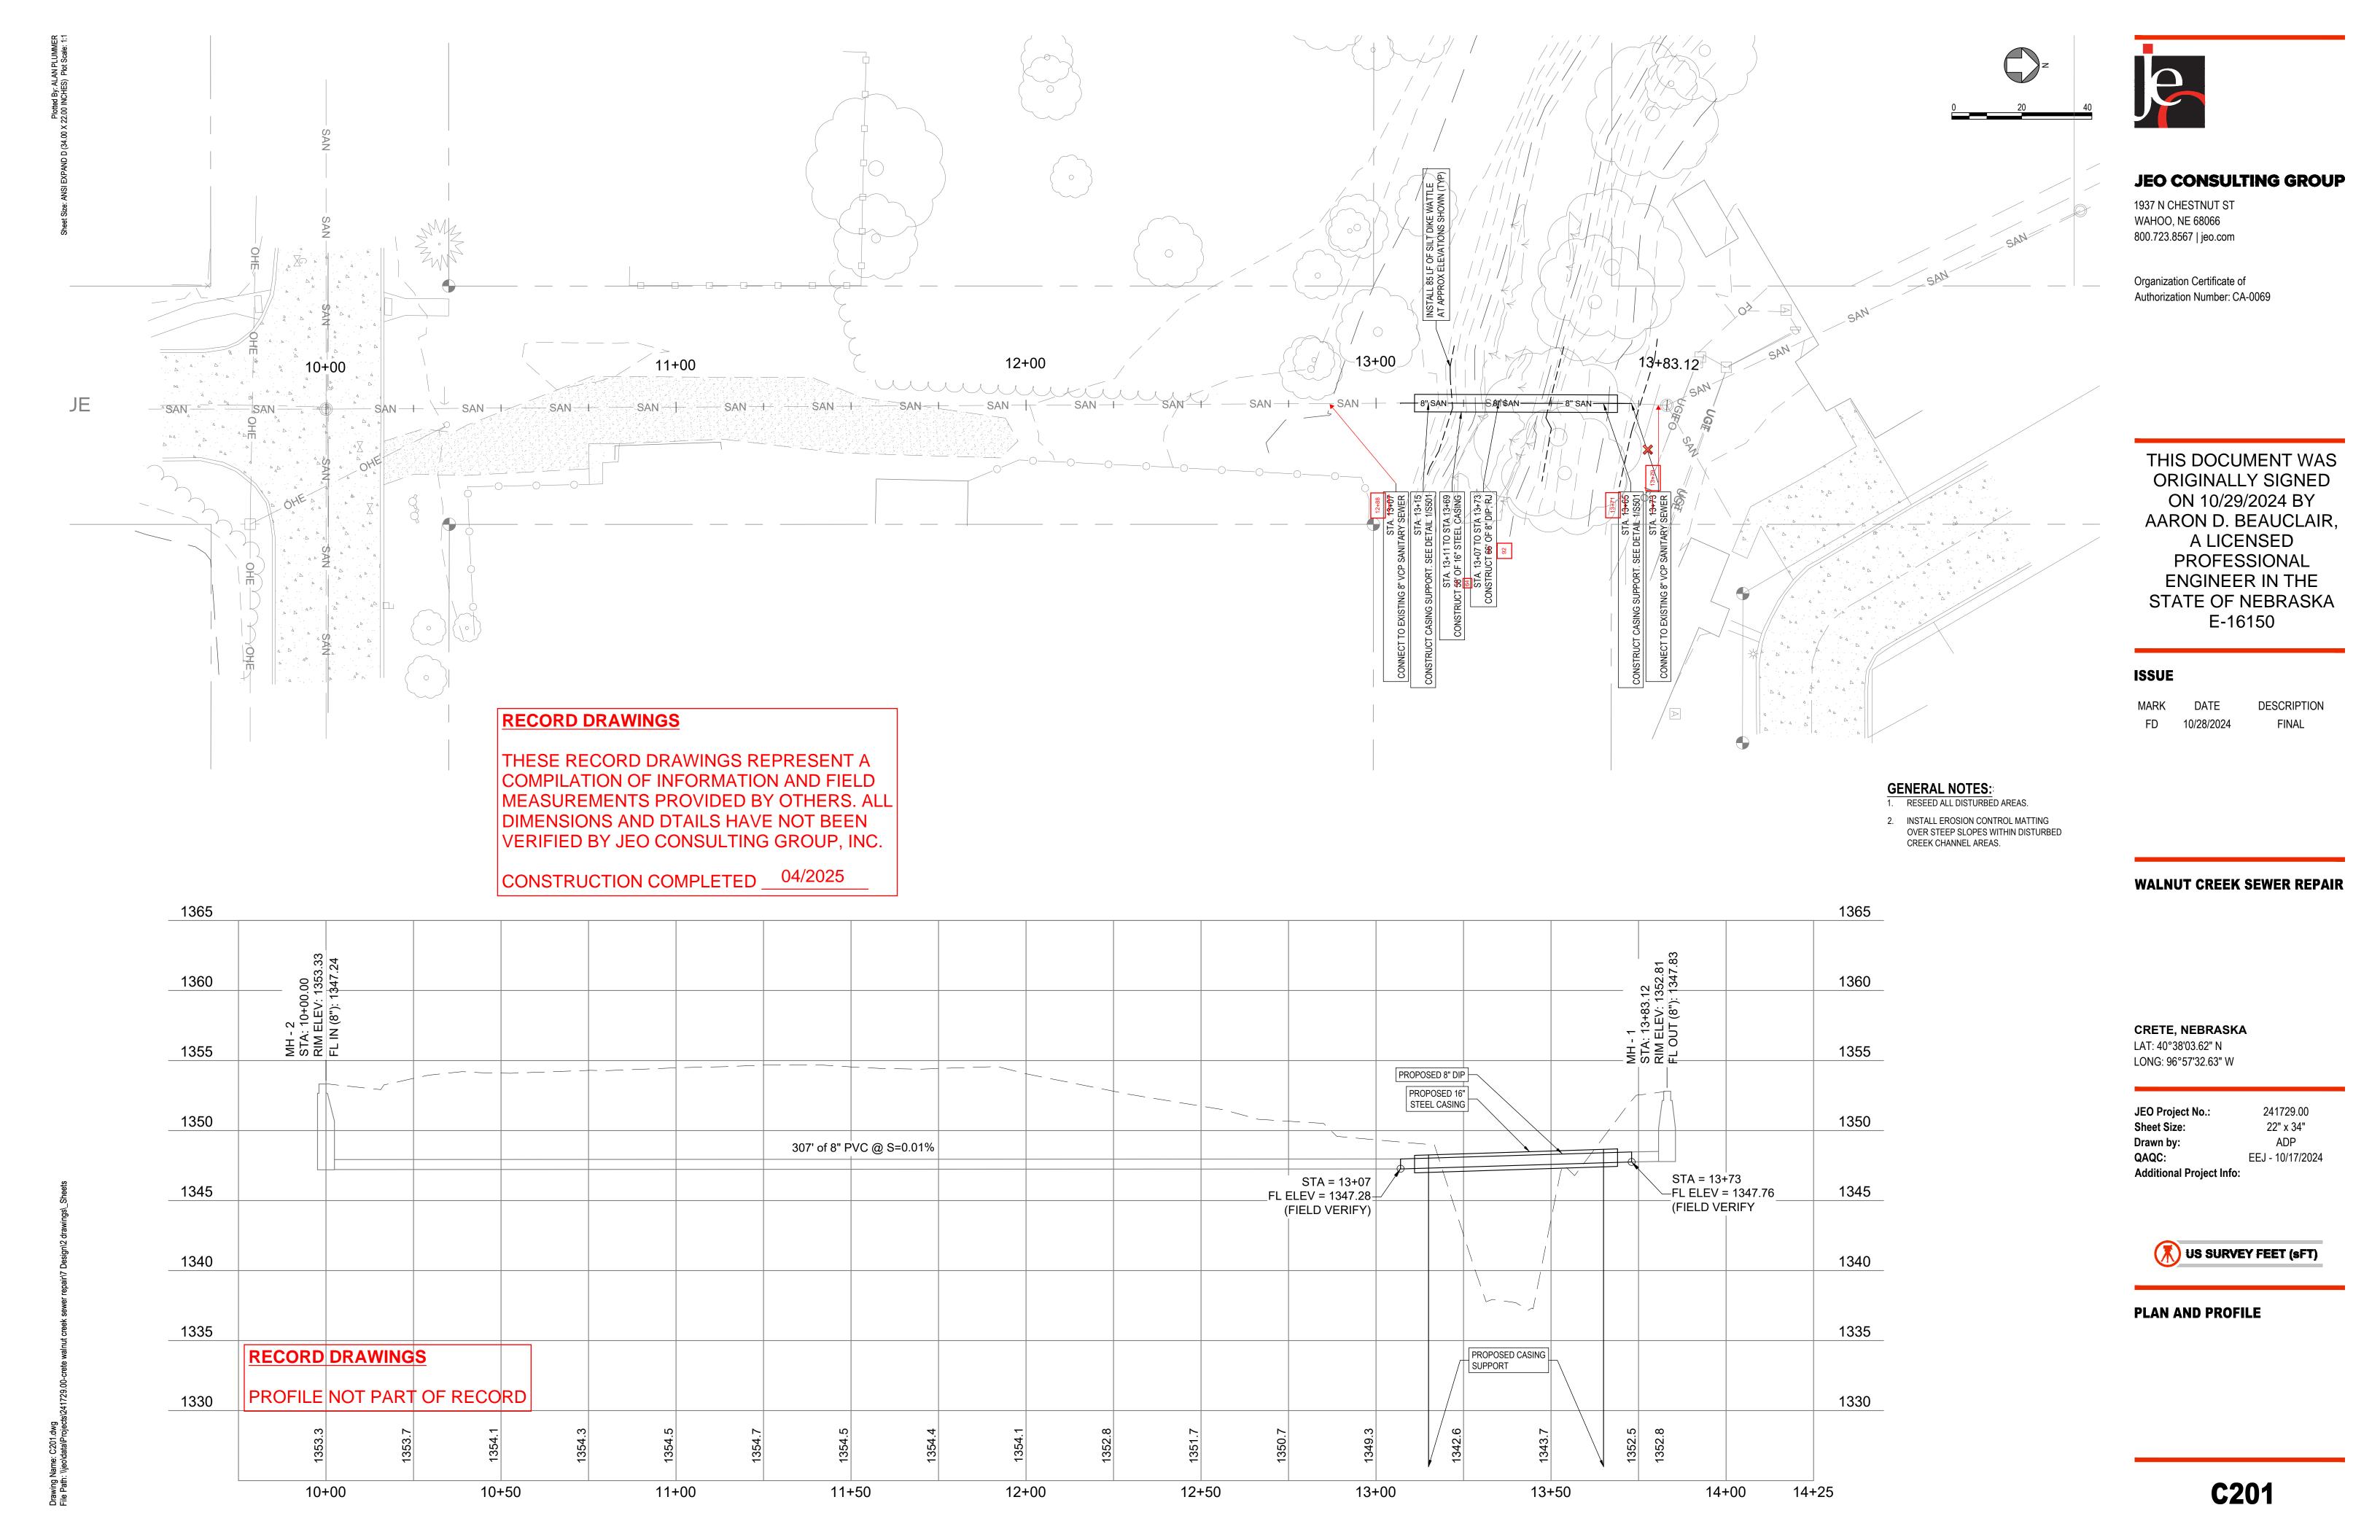

CARRIER PIPE DIA.

CASING CHOCK LENGTH

MIN. CASING DIA

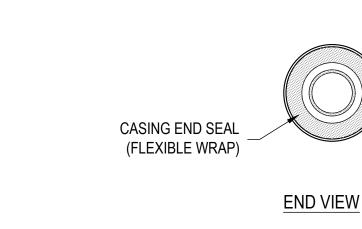

CASING AND CHOCK DETAIL TABLE


CASING CHOCK (TYP)

4" 6" 8" 10" 12" 16" 24"

10" 12" 14" 16" 20" 24" 36"

8" 8" 8" 8" 12" 12"

6' SPACING (MAX)

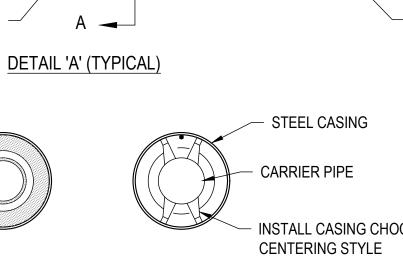


2' MAX (TYP)

INSTALL CASING CHOCKS,

SECTION A-A (TYPICAL)



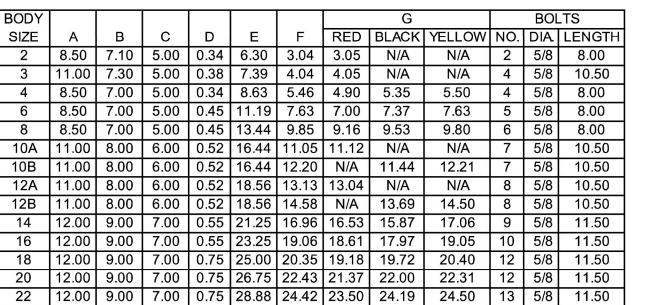

FASTENERS: HSLA PER AWWA C111. STAINLESS STEEL TYPE 304 OR 316 AVAILABLE UPON REQUEST. PRESSURE RATED UP TO 260 PSIG WORKING, 325 PSIG TEST. FOR HIGHER PRESSURES CONTACT ROMAC ENGINEERING DEPARTMENT.


CASING END SEAL, SEE

SPECIFICATIONS


END OF CASING

AROUND PIPE

2" FIBERGLASS BATT

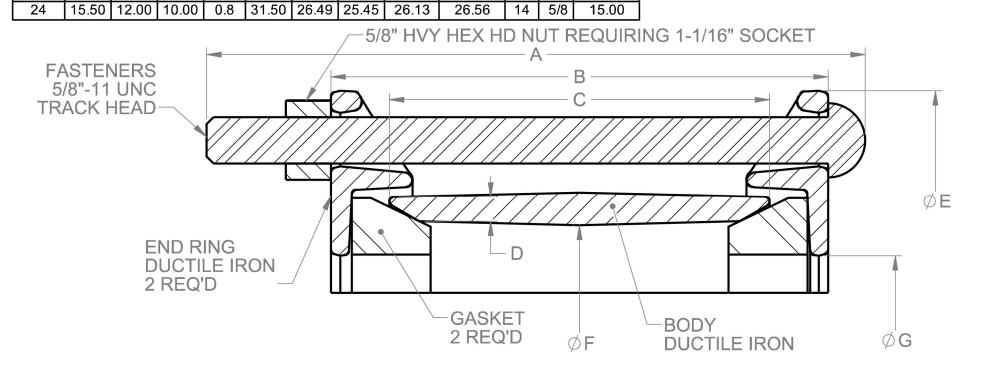




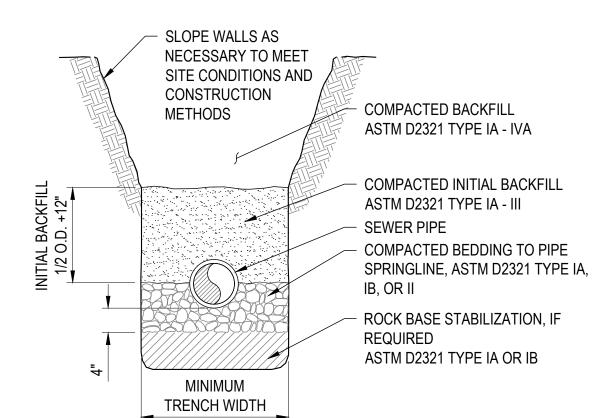

	MIN.
PIPE SIZE	TRENCH
	WIDTH
4"	18"
6"	18"
8"	24"
10"	26"
12"	30"
15"	30"
18"	32"

SCALE: N.T.S.

SANITARY SEWER TRENCH

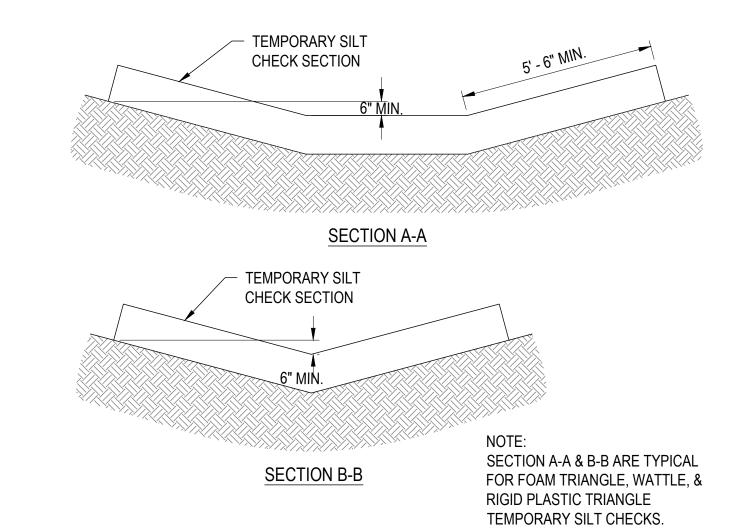

SILT DIKE WATTLES

CONSTRUCTION COMPLETED _

SCALE: N.T.S.

ISSUE

DESCRIPTION DATE 10/28/2024 FINAL

JEO CONSULTING GROUP

THIS DOCUMENT WAS

ORIGINALLY SIGNED

ON 10/29/2024 BY

AARON D. BEAUCLAIR,

A LICENSED

PROFESSIONAL

ENGINEER IN THE

STATE OF NEBRASKA

E-16150

1937 N CHESTNUT ST

800.723.8567 | jeo.com

Organization Certificate of

Authorization Number: CA-0069

WAHOO, NE 68066

WALNUT CREEK SEWER REPAIR

CRETE, NEBRASKA


LAT: 40°38'03.62" N LONG: 96°57'32.63" W

241729.00 **JEO Project No.:** 22" x 34" **Sheet Size:** ADP Drawn by: QAQC: EEJ - 10/17/2024

Additional Project Info:

(X) US SURVEY FEET (sFT)

DETAILS

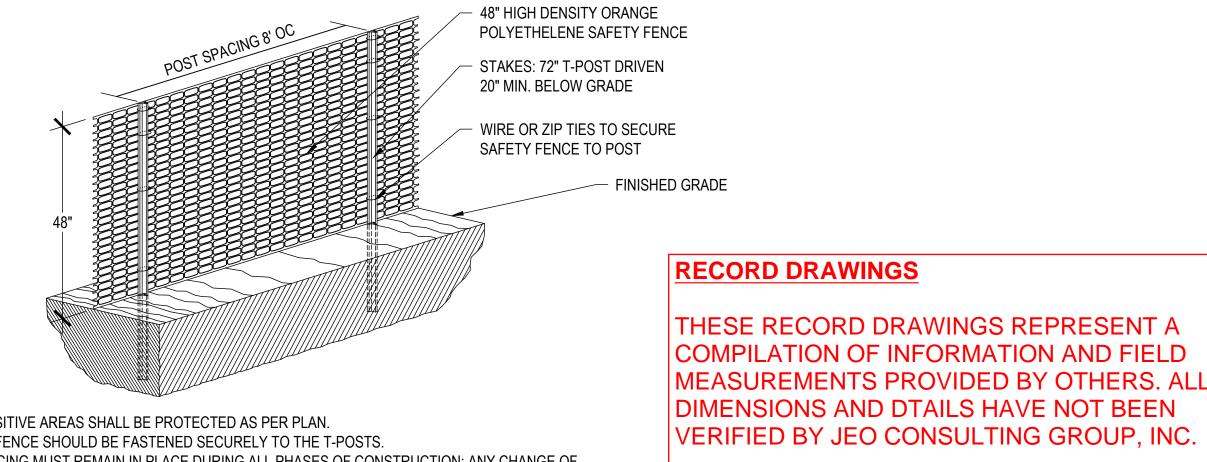

1. ALL SENSITIVE AREAS SHALL BE PROTECTED AS PER PLAN.

2. SAFETY FENCE SHOULD BE FASTENED SECURELY TO THE T-POSTS.

3. THE FENCING MUST REMAIN IN PLACE DURING ALL PHASES OF CONSTRUCTION; ANY CHANGE OF THE PROTECTIVE FENCING MUST BE APPROVED. PROTECTIVE FENCING MUST BE APPROVED.


ORANGE SNOW FENCE

MEASUREMENTS PROVIDED BY OTHERS. ALL

DIMENSIONS AND DTAILS HAVE NOT BEEN

CONSTRUCTION COMPLETED ___04/2025

VERIFIED BY JEO CONSULTING GROUP, INC.

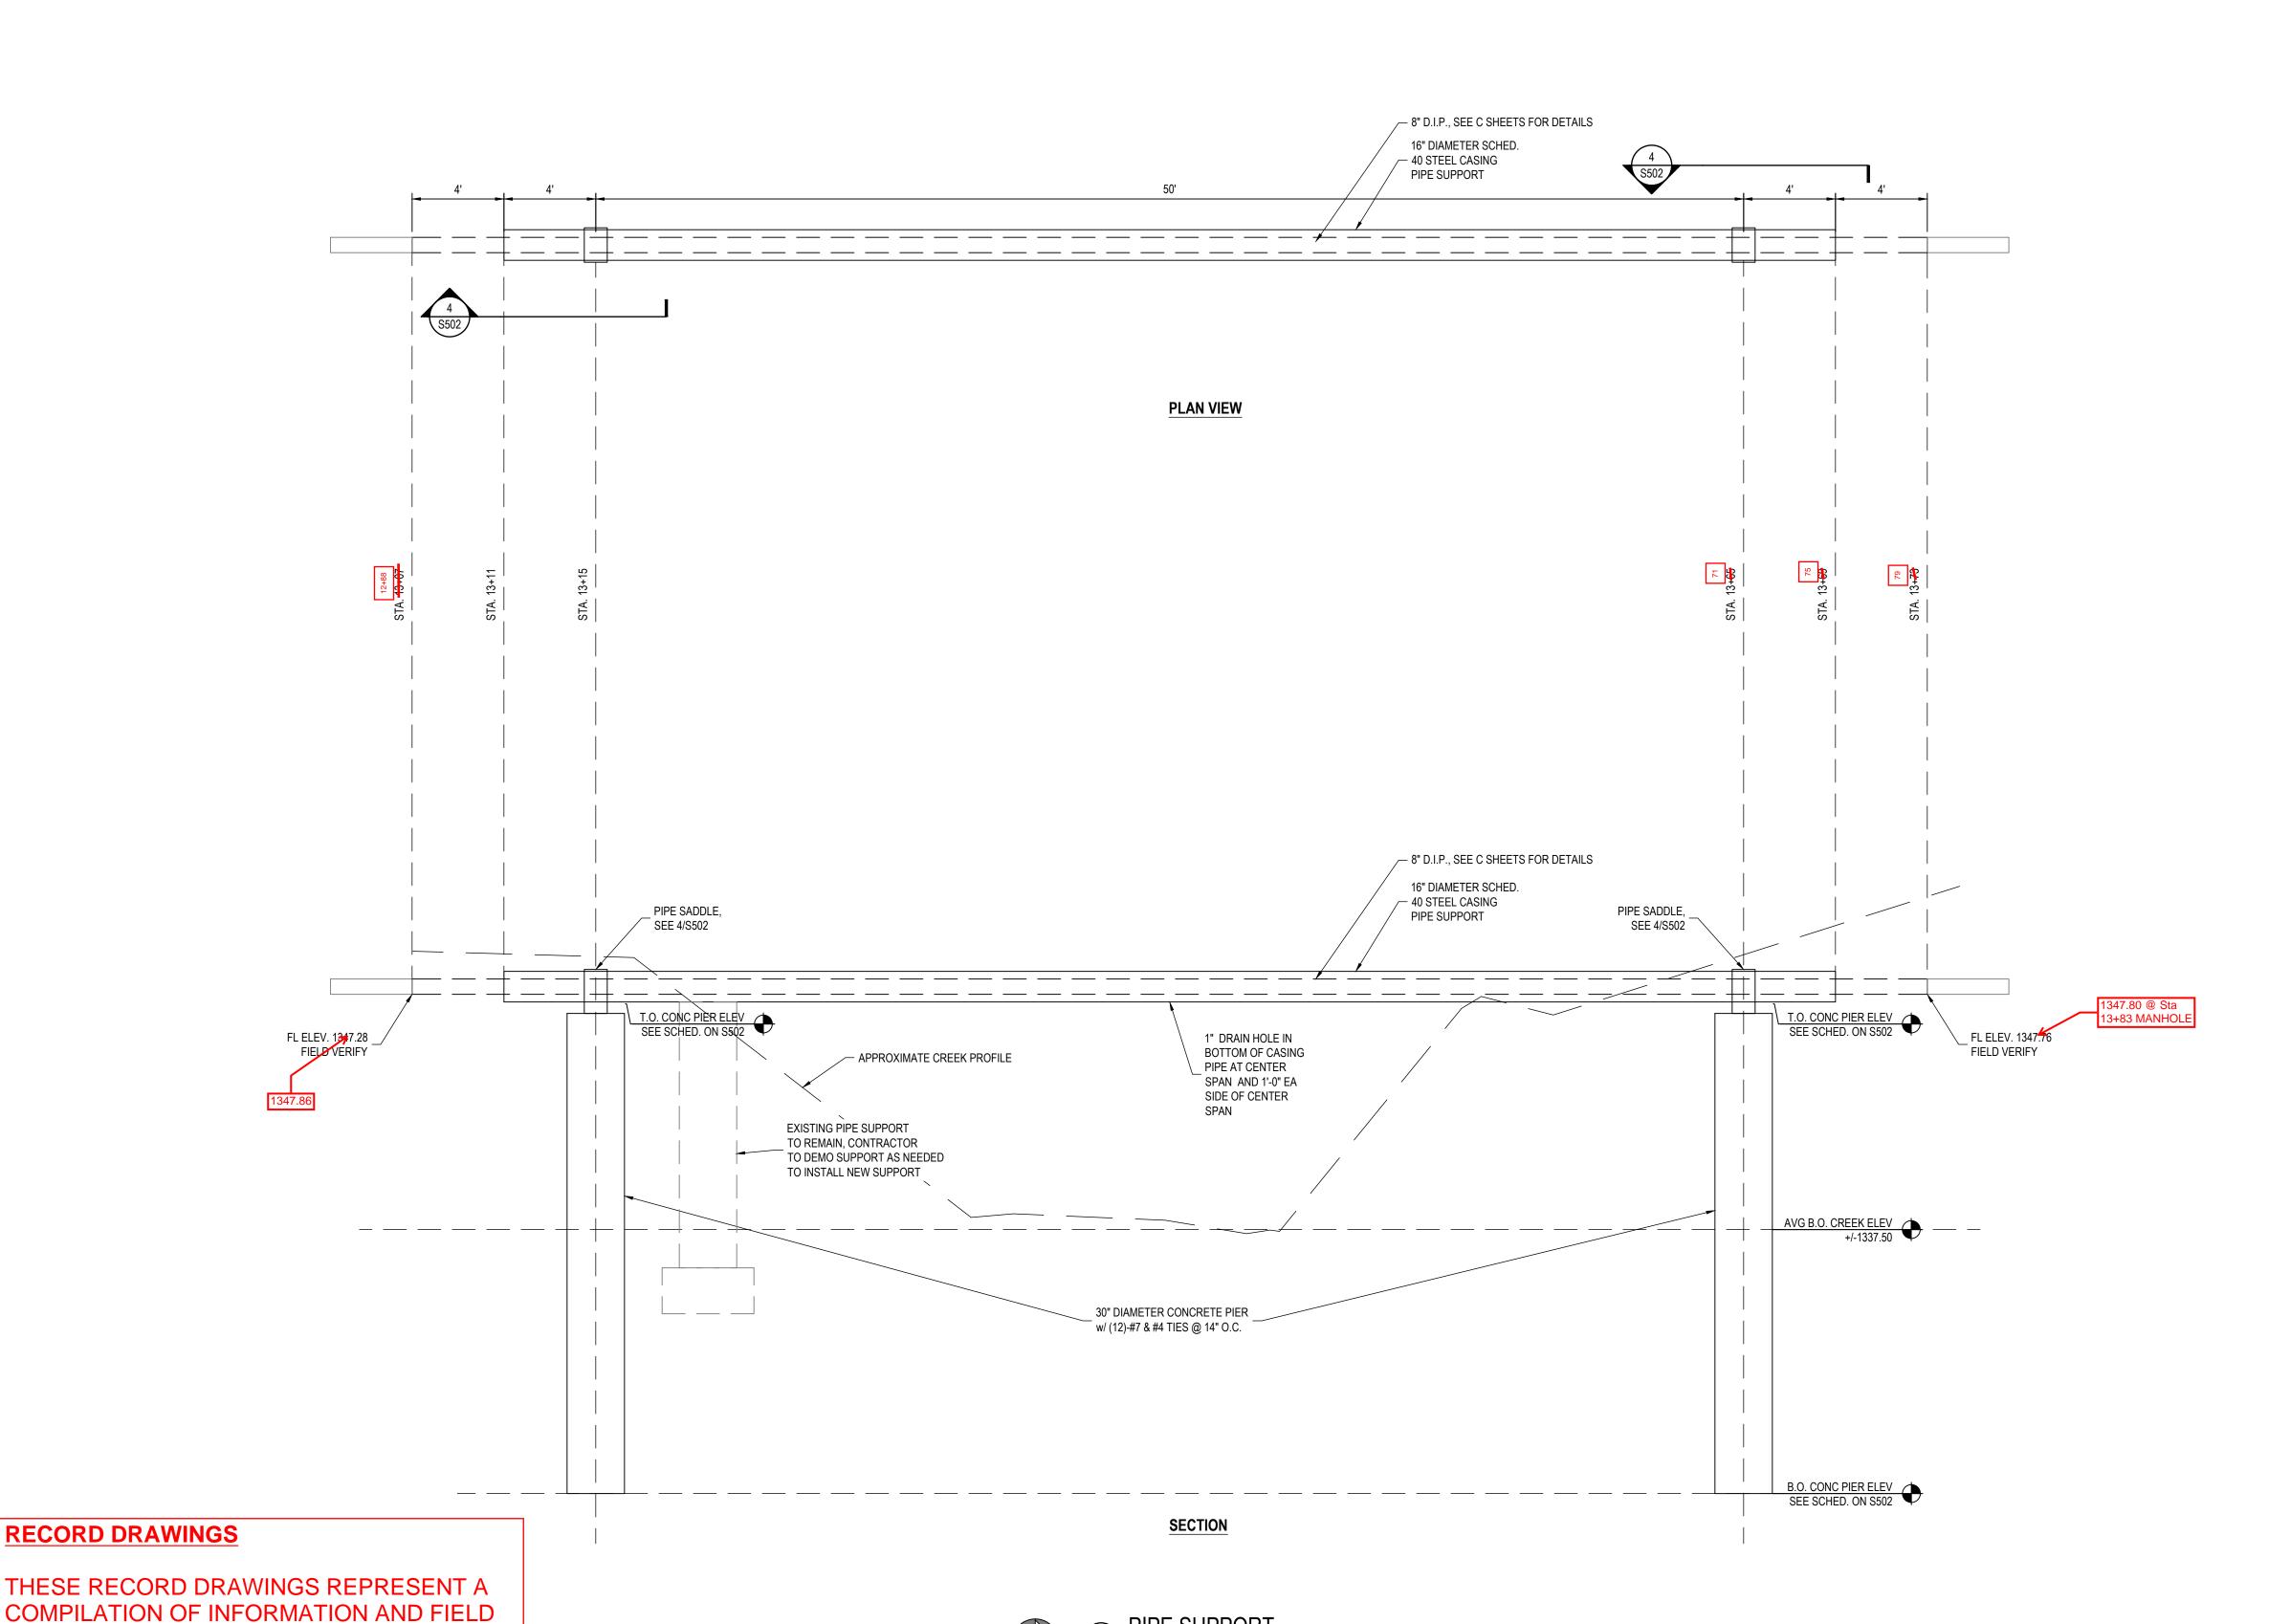

PIPE SUPPORT

JEO ARCHITECTURE INC

1937 N CHESTNUT ST WAHOO, NE 68066 800.723.8567 | jeo.com

Organization Certificate of Authorization Number: CA-3929

THIS DOCUMENT WAS ORIGINALLY SIGNED ON 10/29/2024 BY CODY A. LUREEN A LICENSED PROFESSIONAL **ENGINEER IN THE** STATE OF NEBRASKA E-18811

ISSUE

DESCRIPTION 10/28/2024

WALNUT CREEK SEWER REPAIR

CRETE, NEBRASKA LAT: 40°38'03.62" N LONG: 96°57'32.63" W

JEO Project No.: 241729.00 22" x 34" Sheet Size: ADP Drawn by: EEJ - 10/17/2024 Additional Project Info:



STRUCTURAL DETAILS

DESIGN DATA - STRUCTURAL GENERAL NOTES

GOVERNING CODE/SPECIFICATIONS:

2018 International Building Code (IBC), and Nebraska Department of Transportation (NDOT) 2017 Standard Specifications.

DESIGN LOADING:

50 Year flood stream velocity: 9 FPS Design Ice Thickness: 1.50' Bearing Capacity: 1500 psf (Assumed) Blows/Foot: N=4 (Assumed)

MATERIALS:

STRUCTURAL STEEL - ALL STEEL @ SUPPORTS, INCLUDING ENTIRE PIPE SADDLE SUPPORT TO BE H.D.G. (HOT-DIPPED GALVANIZED)

Rolled Shapes & Plates (at supports)......ASTM A-36 H.D.G.ASTM A53 GRADE B Welding Electrodes.....AWS D1.1, type required for materials being welded BOLTS......ASTM A325 TYPE Anchor Bolts......ASTM F1554 Gr. 36 H.D.G. ALL WELDS TO BE SPRAY GALVANIZED WITH ZINC RICH PRIMER

CONCRETE

MIX DESIGNNDOT 47B-3000 ..ASTM-A615 GRADE 60 DEFORMED BARS REINFORCING..

TYPICAL NOTES:

- 1. Construction shall be per the current version of the NDOT standard specifications for highway construction.
- 2. The contractor shall verify specifications, dimensions, and existing site conditions, including utilities, prior to starting work. any deviations or inconsistencies found shall be brought to the immediate attention of the
- 3. The structure and elements shown on the plans are designed for stability under the final configuration only. The contractor is solely responsible for structural stability during construction.
- 4. All de-watering requirements for construction are the responsibility of the contractor.
- 5. No geotechnical investigation was done prior to design. Minimum soil standards were used for design. Geotechnical engineer is to be retained by <u>OWNER</u> to provide continuous testing and observation during all earthwork and pier construction. Geotech engineer to ensure minimum acceptable design criteria is met.

STRUCTURAL STEEL NOTES:

- 1. Structural steel shall be fabricated and erected in conformance with "AISC Specification for Design, Fabrication, and Erection of Structural Steel For Buildings".
- Nuts, bolts, and washers used in the assembly shall be hot—dipped galvanized. Comply with American Welding Society standards. ALL welders shall have valid certificates and have current experience in the types of welds called for. All
- welds to meet AWS D1.1 standards. 4. Submit shop drawings for all structural steel to the ENGINEER for approval.

CONCRETE PIER NOTES:


- 1. All piers shall be driven per Section 702, 704 and 707 of NDOT Standard
- 2. Pier installation shall be observed and recorded by the engineer.
- 3. Allow concrete to cure to 75% design strength (2250 psi), before applying any
- 4. Concrete reinforcement clear cover is to be 2" clear at top of pier and 3" clear everywhere unless noted otherwise (U.N.O.)
- 5. No permanent casing or stay in place forming is allowed.
- 6. Submit concrete mix design to engineer for review.




RECORD DRAWINGS


THESE RECORD DRAWINGS REPRESENT A COMPILATION OF INFORMATION AND FIELD MEASUREMENTS PROVIDED BY OTHERS. ALL DIMENSIONS AND DTAILS HAVE NOT BEEN VERIFIED BY JEO CONSULTING GROUP, INC.

CONSTRUCTION COMPLETED _

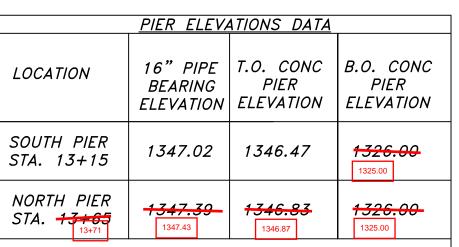


- PIER DATA NOTES:
- T.O. = Top of • B.O. = Bottom of
- See structural general notes, plan and details for additional information
- Contractor to verify all existing elevations prior to construction

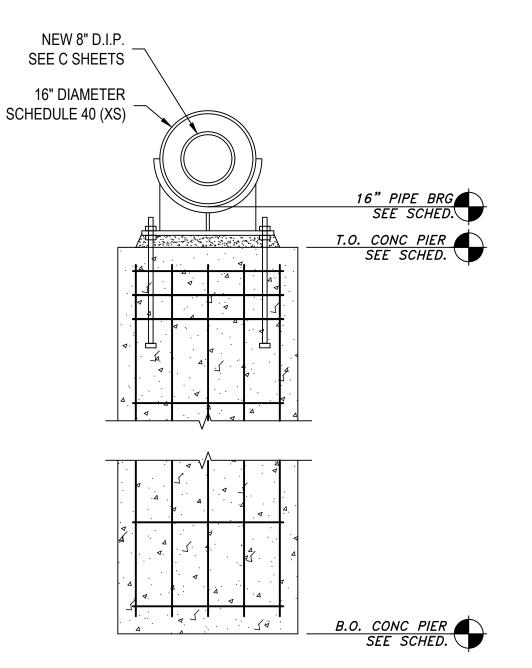

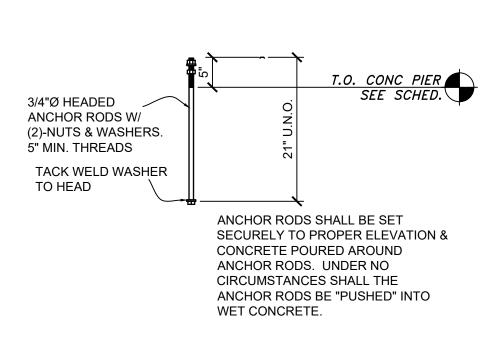

PIER ELEVATION TABLE & DETAIL SCALE: NO SCALE

TYPICAL ANCHOR DETAIL SCALE: NO SCALE

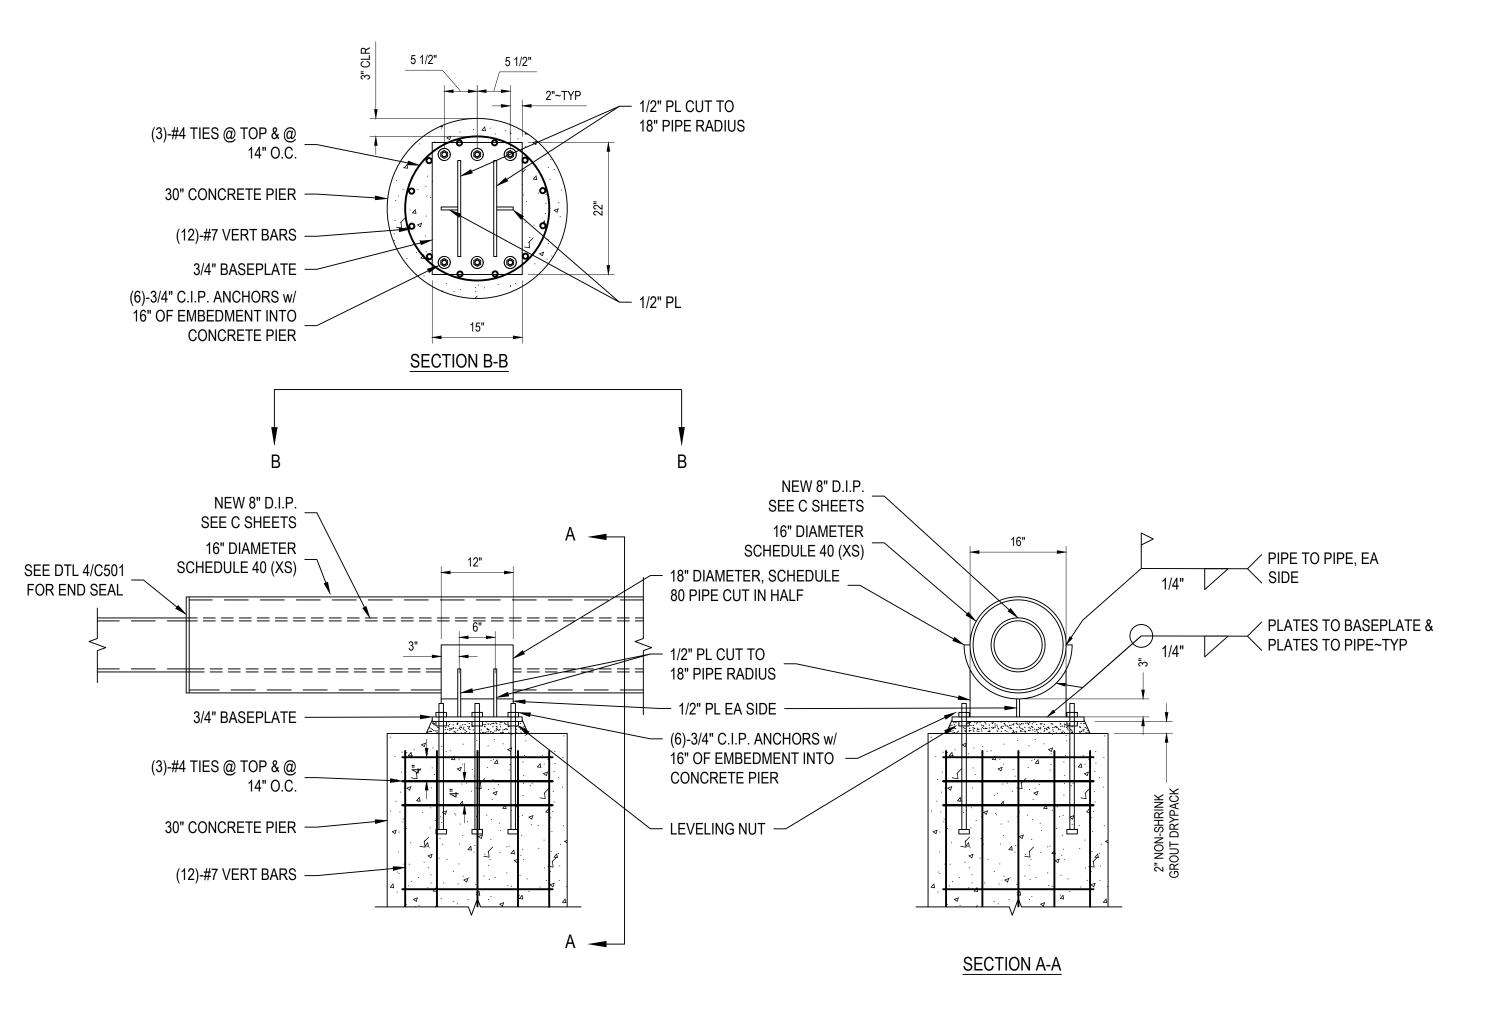



JEO ARCHITECTURE INC

1937 N CHESTNUT ST WAHOO, NE 68066 800.723.8567 | jeo.com

Organization Certificate of Authorization Number: CA-3929

THIS DOCUMENT WAS ORIGINALLY SIGNED ON 10/29/2024 BY CODY A. LUREEN A LICENSED **PROFESSIONAL ENGINEER IN THE** STATE OF NEBRASKA E-18811

ISSUE

DESCRIPTION 10/28/2024

WALNUT CREEK SEWER REPAIR

CRETE. NEBRASKA LAT: 40°38'03.62" N

LONG: 96°57'32.63" W

241729.00 **JEO Project No.:** 22" x 34" **Sheet Size:** Drawn by: ADP QAQC: EEJ - 10/17/2024 **Additional Project Info:**



STRUCTURAL DETAILS